

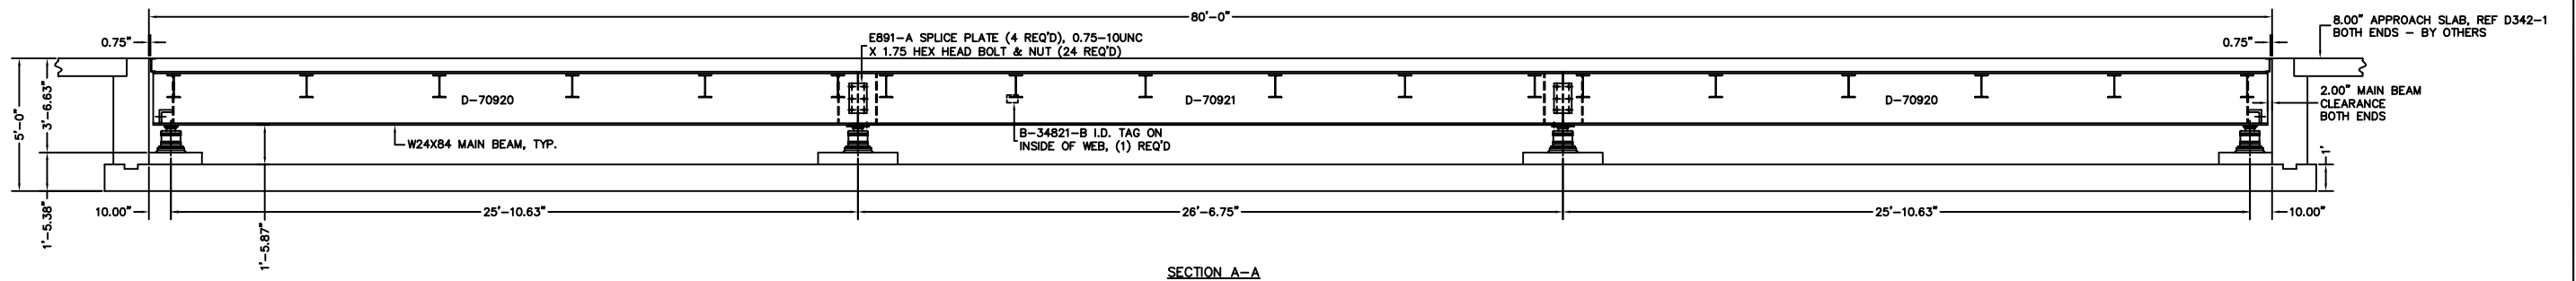
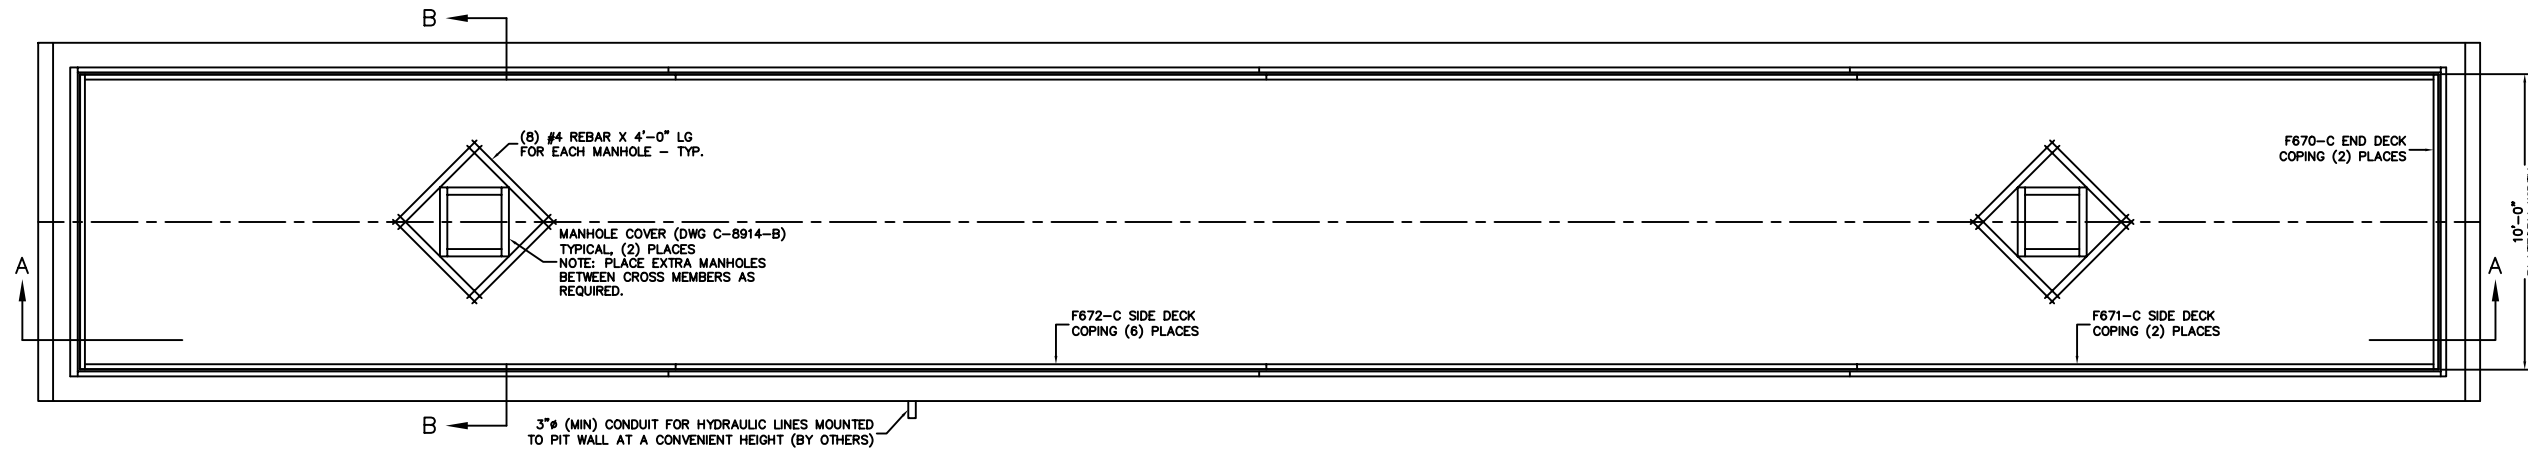


PRELIMINARY NOT FOR CONSTRUCTION

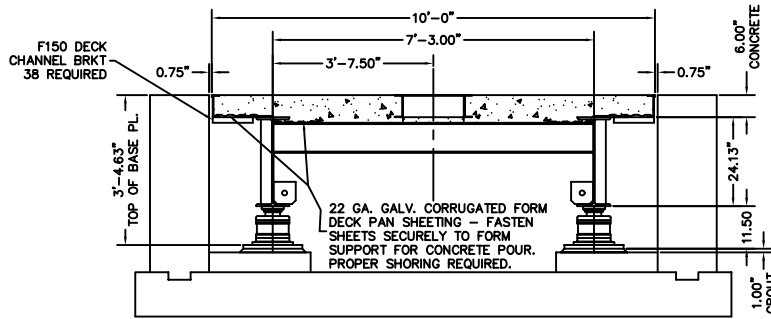

**NOTE:**  
**DIMENSIONAL CENTERS, PIER HEIGHTS & LOCATIONS TBD AS PER NEW DESIGN. FOR ILLUSTRATION ONLY.**

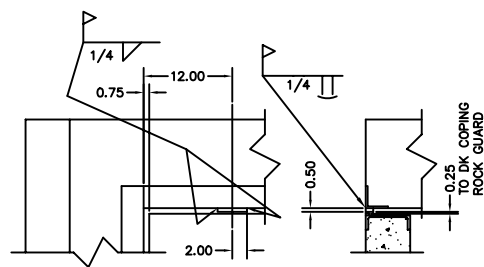

- NOTES:**
- REFERENCE INFORMATION:  
 FOUNDATION PLAN D-70919-A  
 PIPING DIAGRAM (4 SECTION) B-33069-D  
 DECK REINFORCING DETAIL D-45928 LINE 29  
 DECK CHANNEL INSTALLATION D-93028-D  
 APPROACH D342-1  
 LOAD CELL INSTALLATION INSTR. F987-B  
 NTEP NUMBER 92-086PA2  
 CLC 80,000 LB  
 DUAL TANDEM AXLE CAPACITY 100,000 LB  
 LOADING AT EACH LOAD CELL 50,000 LB
  - CRANE CAPACITY & INSTALLATION NOTES:  
 THE MINIMUM CAPACITY IS 5600 LB, LARGEST PIECE APPROXIMATELY 27' X 8' X 2'. SET TWO END BRIDGES FIRST, FOLLOWED BY THE CENTER BRIDGE SUCH THAT THE CENTER BRIDGE IS CONNECTED TO THE END BRIDGES BY THE FOUR (4) LOAD PLATES WITH CENTERING RINGS ET AL. ALIGN BRIDGES AND INSTALL SPLICE PLATES.
  - FOR COMMERCIAL SCALES CHECK WITH LOCAL WEIGHTS AND MEASURES OFFICIALS BEFORE STARTING CONSTRUCTION. NATIONAL BUREAU OF STANDARDS HANDBOOK 44 REQUIRES:  
 A.) A STRAIGHT APPROACH OF AT LEAST ONE-HALF THE LENGTH OF THE PLATFORM.  
 B.) NOT LESS THAN 10 FEET OF APPROACH ADJACENT TO THE PLATFORM TO BE CONSTRUCTED OF CONCRETE OR SIMILAR DURABLE MATERIAL AND BE LEVEL AND IN THE SAME PLANE AS THE PLATFORM.  
 FOR NON COMMERCIAL SCALES PROVIDE AN APPROACH OF 2 FEET MINIMUM LENGTH WHICH IS LEVEL AND IN THE SAME PLANE AS THE PLATFORM.
  - CHECK WITH THE PROPER REGULATORY AUTHORITIES AS TO ANY SPECIAL STATE OR OTHER REGULATORY REQUIREMENTS REGARDING PIT DEPTHS. PIT CONSTRUCTION AND APPROACH DIMENSIONS WHICH MIGHT AFFECT INSTALLATION ARE SHOWN. EMERY WINSLOW WILL ASSUME NO RESPONSIBILITY FOR CHANGES NECESSITATED BY ANY STATE OR ANY OTHER REGULATORY REQUIREMENTS AS TO INSTALLATION OF OUR SCALES.

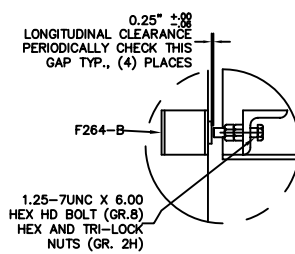
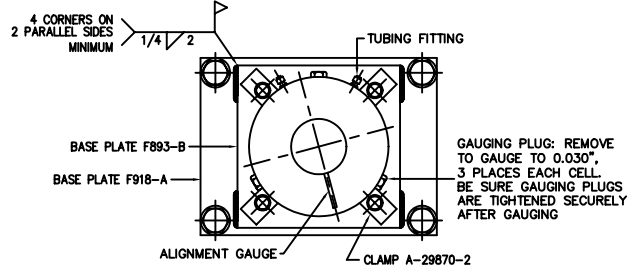
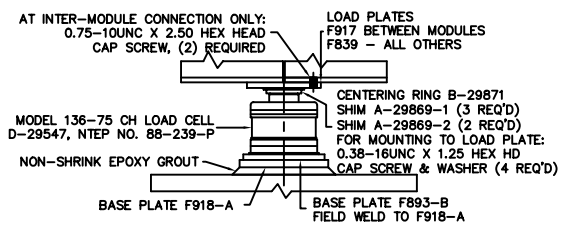


ILLUSTRATION ONLY

C	DETAILS TO SCALE, REV'S UPDATED	06/02	CES	ALL SHARP CORNERS AND EDGES TO BE BROKEN	EMERY WINSLOW SCALE COMPANY SEYMOUR, CT U.S.A TERRE HAUTE, IN.
B	NOTE 2 WAS CORRECTED	07/01	CES	UNLESS OTHERWISE SPECIFIED DIMENSIONS ARE IN INCHES	
A	CRANE CAPACITY WAS 5500	07/01	CES	MACHINING FABRICATION ±.13 ±.13	MODEL 44-10080-10 w/6" CD AND 4' PIT OUTLINE ARRANGEMENT
LTR	REVISION	DATE	BY	DRAWN CES DATE 07/17/01	SCALE 1:36 FIRST USED ON DRAWING NO. REV. C
THIS DRAWING IS THE PROPERTY OF EMERY WINSLOW SCALE COMPANY SEYMOUR, CONNECTICUT. THE INFORMATION CONTAINED HEREIN IS CONFIDENTIAL AND IS NOT TO BE USED OR DISSEMINATED TO OTHERS WITHOUT THE EXPRESS WRITTEN CONSENT OF EMERY WINSLOW SCALE COMPANY.				CHECKED DATE ACAD FILENAME: 101098 LAYERS USED: ALL	D-70918

FULL SIZE PLOT D-24X36